## Elm Street Cemetery - Fence Restoration

Elm Street / Railroad Street Braintree, MA 02184



	DRAWING LIST
Sheet Number	Sheet Name

A1.0	Site Plan
A1.1	Elm Street Fence
A1.2	Elm Street Post Details
A1.3	Elm Street Post and Railing Details
A1.4	Elm Street Railing Details
A2.1	Gates and Stone Piers
A2.2	Gate Details
A7.1	Railings and Posts Schedule






## **GENERAL NOTES:**

- 1. Protect the public at all times from potential construction hazards.
- 2. The cemetery will be open to the public during this project. All existing entries and means of egress must be maintained.
- 4. Work of this contract shall be coordinated with the restoration work of the masonry being performed under a seperate contract.
- 5. The Contractor shall visit the site and thoroughly examine and become familiar with existing conditions including delivery and removal of materials to and from the site.
- 6. Work described in either drawings or specification shall be considered part of this contract.
- 7. Field dimensions and dimensional coordination shall be the responsibility of the Contractor. It is the intention of the contract that the completed dimensions match the existing fence
- 8. Sections and details apply to all similar conditions unless otherwise noted.
- 9. Restore any damage to building or site caused during construction to its condition prior to the start of construction.
- 10. Control noise. Contain all dust and legally dispose of all construction debris.
- 11. Do not scale the drawings. If critical dimensions are missing from the drawings contact
- 12. Contractor will have access to water via an exterior hose bibb, and will not be charged
- 13. Contractor will have access to existing circuitry for power, and will not be charged for power usage. If the Contractor requires additional power, the Contractor shall be responsible for all work associated with installing additional electrical wiring, including removal of any temporary electrical work.
- 14. Work hours will be 7AM 5PM, Monday through Friday. 8AM 5 PM on Saturday (by special arrangement with Owner). No work on Sunday.
- 15. At the completion of all work, the Contractor shall remove all construction debris and material and repair damage caused to the site during construction.
- 16. Submit a full sized sample of all visible products for review and approval prior to the start of fabrication or construction.
- 17. "Requests for Information" RFI's are a normal and expected part of the construction process. In submitting an RFI, the Contractor shall also submit a recommended detail or solution. The Contractor shall also indicate if the Contractor feels that the recommended detail or solution is a proposed increase to the contract sum.
- 18. The contractor is to assume that there is the presence of lead based paint on all fencing and gare components. The contractor is to follow all laws to properly disponse of the lead based paint.

## **SCOPE NOTES:**

- Remove and disassemble all cast iron fence and gate assembly's for shop restoration
- Provide new sub rail and bottom rail at all fence and gate sections
- Shop sandblast all existing elements to be reused. Install hot dip galvanized primer with urethane top coat and finish under base bid. In Alternate 1 provide a zinc rich primer, Epoxy mid coat and Urethane top coat system and a ss replacement bottom bar and subrail. Bottom bar and sub rail to be carbon steel in base bid.
- Paint on the cast iron fence is lead containing. The contractor is responsible for complying with all lead removal rules and regulations.
- Provide new SS threaded rod, bars, and fasteners to reattach posts and rails.
- Provide new brass bearings and stainless steel end to all gate panels
- Temporary fence will be installed and removed by the Town of Braintree

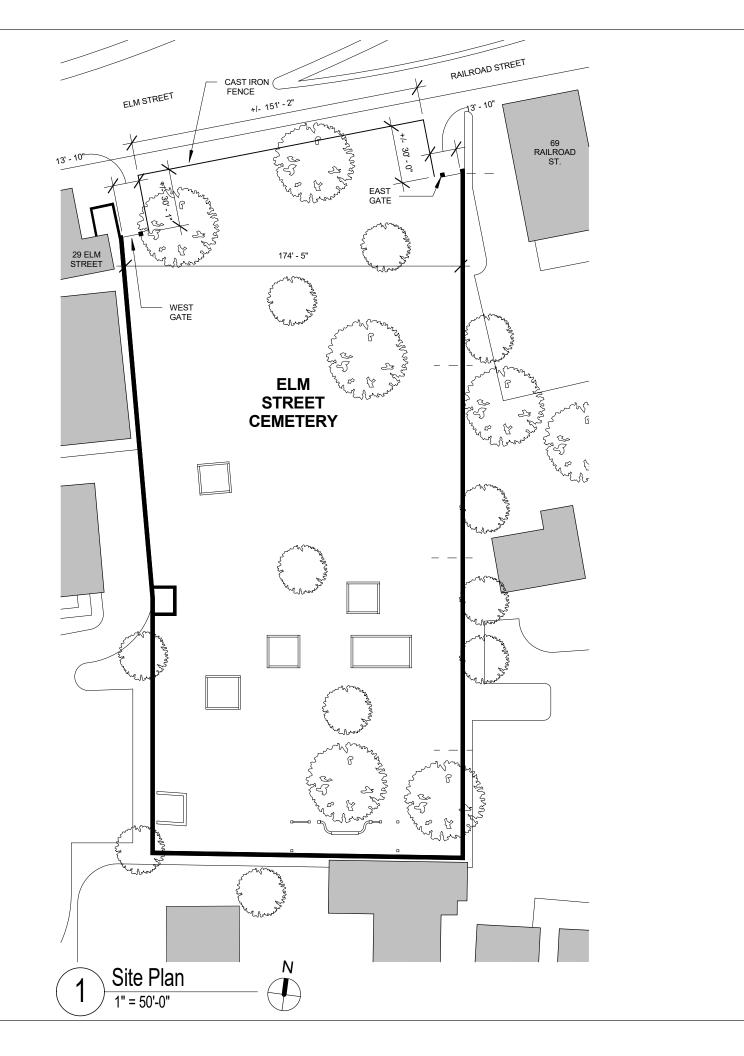



Street Cemetery Fence Restoration

Elm

Elm Street / Railroad Street Braintree, MA 02184 Town of Braintree


Date: 07/21/2017 Scale: 1'' = 50'-0''JMC Drawn By: Reviewed By: RAF 1729.02 Project No:

McGinley Kalsow & Associates, Inc.

3 2 4 Broadway, P.O. Box 4 5 2 4 8 Somerville, MA 0 2 1 4 5 617.625.8901 - www.mcginleykalsow.com

Site Plan

A1.0

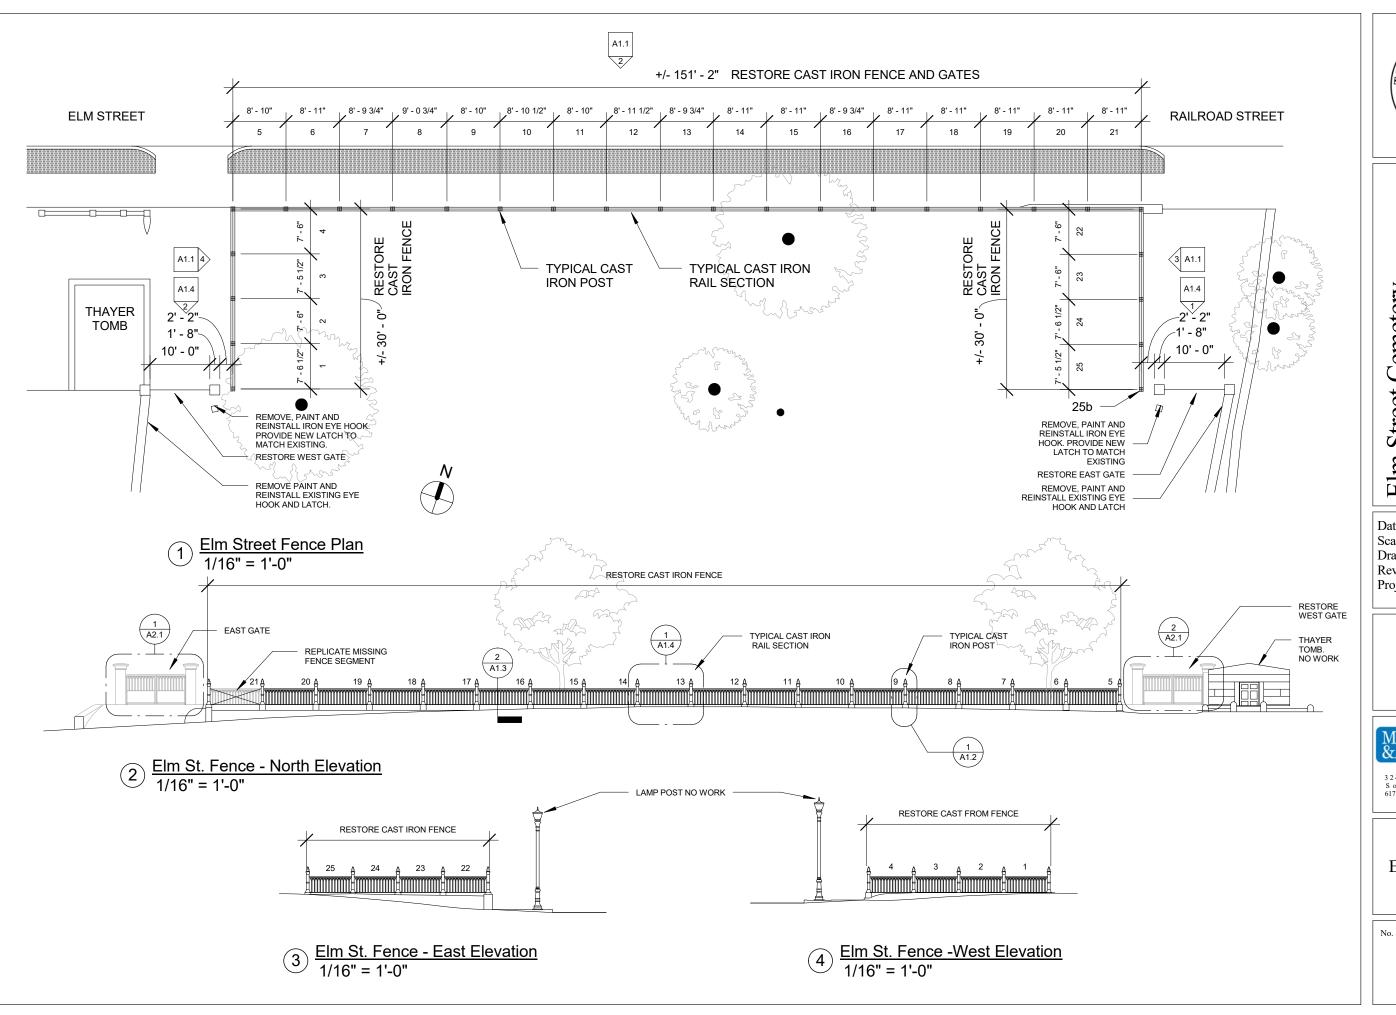



Elm Street Cemetery Fence Restoration

 Date:
 07/21/2017

 Scale:
 1/16" = 1'-0"

 Drawn By:
 JMC

 Reviewed By:
 RAF

 Project No:
 1729.02

Elm Street / Railroad Street Braintree, MA 02184


Town of Braintree



Elm Street Fence

A1.1



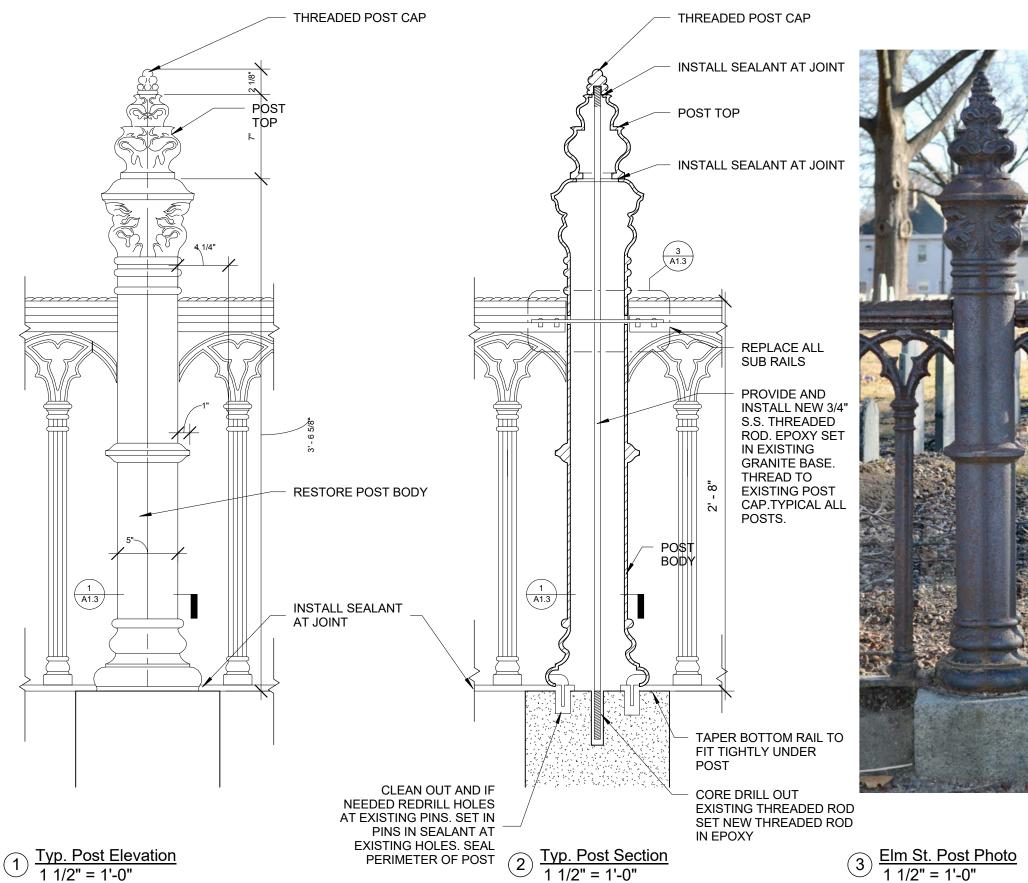





5 Elm St. Post Top
1 1/2" = 1'-0"



6 Elm St. Post Base 1 1/2" = 1'-0"



Elm Street Cemetery Elm Street / Railroad Street Braintree, MA 02184 Fence Restoration

Date: 07/21/2017 1 1/2" = 1'-0" Scale: Drawn By: JMC Reviewed By: RAF Project No: 1729.02

Town of Braintree



Elm Street Post Details

A1.2









Existing Top Rail Photo 6" = 1'-0"




Existing Top Rail to Post Connection 3" = 1'-0"

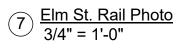

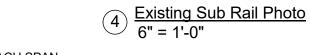



Existing Top Rail Photo 2 6" = 1'-0"

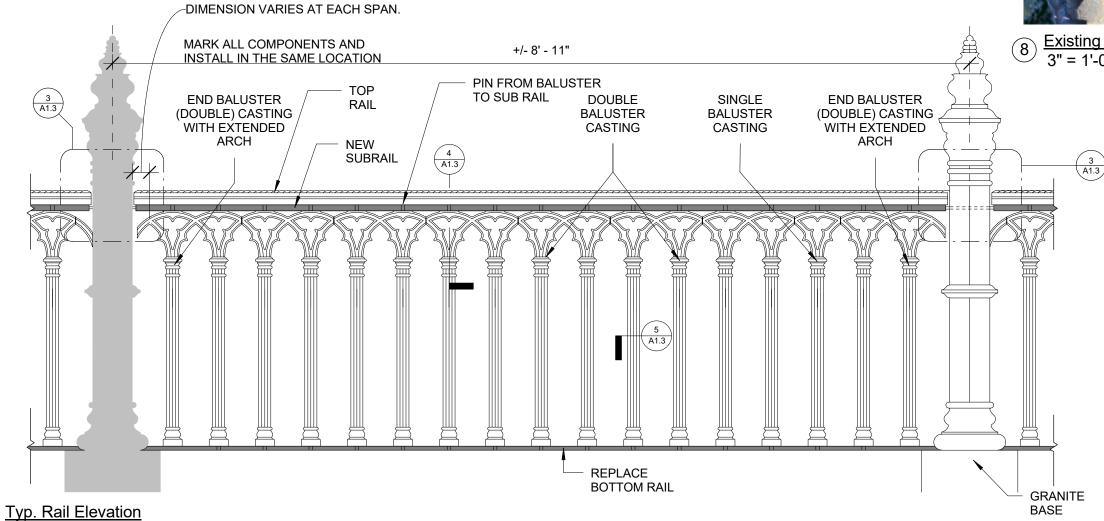



Elm Street Cemetery

Date:

Scale:

Drawn By:

Project No:

Reviewed By:

Fence Restoration

Elm Street / Railroad Street Braintree, MA 02184

07/21/2017 As indicated

JMC

RAF


1729.02

Town of Braintree

Elm Street Railing Details

A1.4

1" = 1'-0"

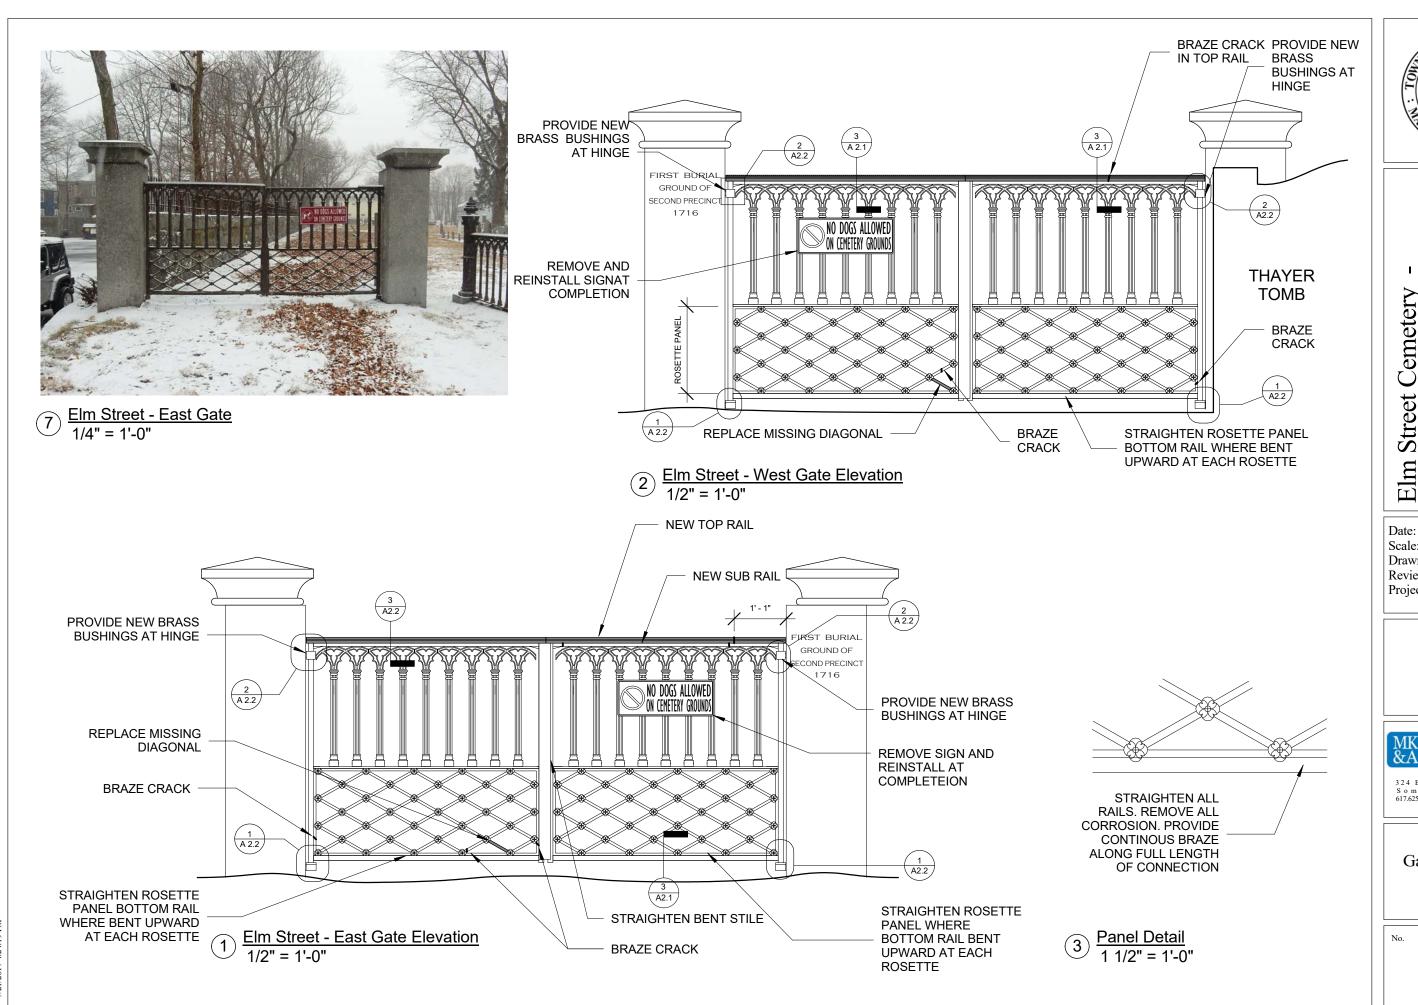



Elm Street Cemetery Fence Restoration

07/21/2017 Scale: As indicated Drawn By: **JMC** Reviewed By: **RAF** Project No: 1729.02


Elm Street / Railroad Street Braintree, MA 02184

Town of Braintree




Gates and Stone Piers


A2.1

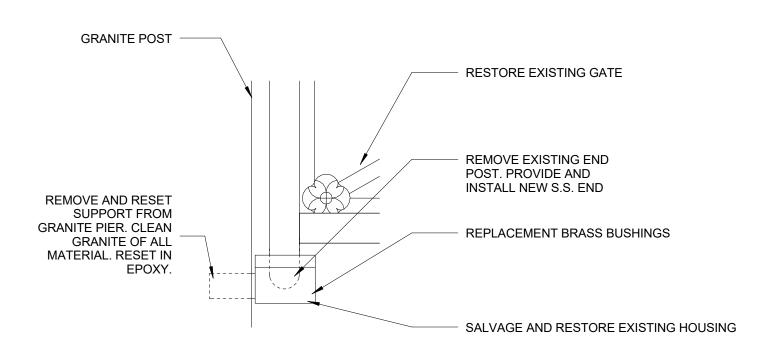


## 1 Gate Bottom Bearing Detail 3" = 1'-0"

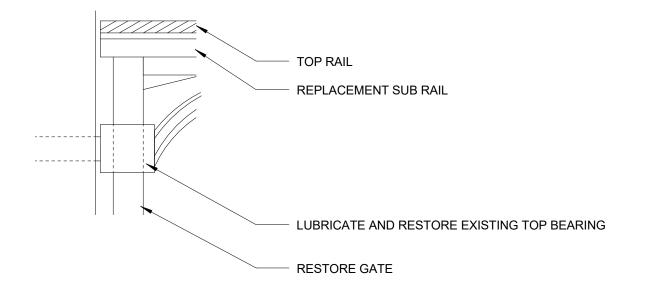

2 Gate Top Bearing Detail
3" = 1'-0"

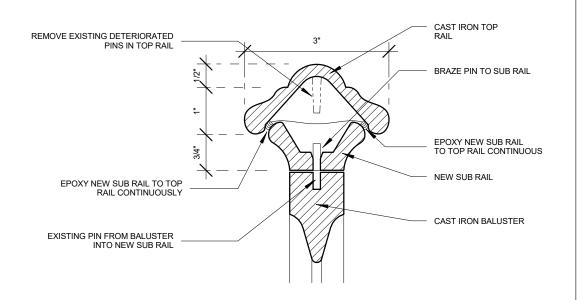

 $3 \frac{\text{Rail Detail}}{6" = 1'-0"}$ 

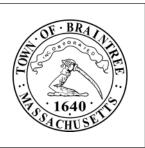

Elm Street Cemetery Fence Restoration Elm Street / Railroad Street Braintree, MA 02184

Date: 07/21/2017 Scale: As indicated Drawn By: JMC Reviewed By: RAF Project No: 1729.02

Town of Braintree



Gate Details

No

A2.2